

www.arboristsnw.com

1710 SW 318PL 44D Federal Way WA. 98023 (206) 779-2579

Tree 1. the Maple will be balled and bagged, stored on site, and replanted a the end of construction. The root ball is to be buried in mulch and monitored by the project arborist weekly or as needed to maintain optimum conditions. Records are to be kept on these site inspections.

Tree 2. The walkway has been redesigned to be at grade. The whole dripline is to be covered in 5-6" of mulch. As previously reported; the soil is compacted around the tree over 300 psi (12 probes were conducted at various distances from the trunk) penetration never was able to exceed ½-2" of depth before the psi went off the chart. The dripline extends over the existing building, and the 3' of over-excavation of the new building will also encroach into the zone. Air spade work will be performed before excavation in this area to ensure that any roots found are properly treated and recorded. Our professional opinion is that with the high level of soil compaction and the current foundation, there will be a minimal number of roots found. The total is well below the ISA standard of no more than 25% of the root plate affected.

Respectfully Submitted

1/18/23

Neal Baker ArboristsNW.com ISA Cert. PN1075A TRAQ ISA (Tree Risk Assessment Qualified) Member AREA & SOCA

CITY OF MERCER ISLAND

COMMUNITY PLANNING & DEVELOPMENT

9611 SE 36TH STREET | MERCER ISLAND, WA 98040

PHONE: 206.275.7605 | www.mercergov.org



MERCER ISLAND TREE INVENTORY & REPLACEMENT SUBMITTAL INFORMATION

PROJECT INFORMATION			
Property Owner Name:			
Site Address or Parcel Number:			
Project Contact Name:			
Contact Email Address:			
Contact Phone Number:			
EXCEPTIONAL TREES			
Exceptional Trees- means a tree or group of trees that because of its unique historical, ecological or aesthetic value constitutes an important community resource. A tree that is rare or exceptional by virtue of its size, species, condition, cultural/historical importance, age, and/or contribution as part of a tree grove. Trees with a diameter of more than 36 inches, or with a diameter that is equal to or greater than the diameter listed in the Exceptional Tree Table shown in MICC 19.16 under Tree, Exceptional.			
List the total number of trees for each category and the tree identification numbers from the arborist report.			
Number of trees 36" or greater List tree numbers:			
Number of trees 24" or greater (including 36" or greater) List tree numbers:			
Number of trees from Exceptional Tree Table (MICC 19.16) List tree numbers:			
LARGE REGULATED TREES			

<u>Large Regulated Trees</u> - means any tree with a diameter of 10 inches or more, and any tree definition of an Exceptional Tree.	that meets the
Number of Large Regulated Trees on site	(A)
List tree numbers:	
Number of Large Regulated Trees on site proposed for removal List tree numbers:	(B)
Percentage of trees to be retained ((A-B)/Ax100) note: must be at least 30%	%
RIGHT OF WAY TREES	
<u>Right of Way Trees</u> - means a tree that is located in the street right of way adjacent to the pro-	oject property.
Number of Large Regulated Trees in right of way	
List tree numbers:	
Number of Large Regulated Trees in right of way proposed for removal	
List tree numbers:	
Reason for removal:	
TREE REPLACEMENT	


Tree replacement- removed trees must be replaced based on the ratio in the table below. Replacement trees shall be conifers at least six feet tall and or deciduous at least one and one-half inches in diameter at base.


			Number of Tree
	Tree	Number of	Required for
Diameter of Removed Tree (measured 4.5'	replacement	Trees Proposed	Replacement Based
above ground)	Ratio	for Removal	on Size/Type
Less than 10"*	1		
10" up to 24"	2		
Greater than 24" up to 36"	3		
Greater than 36" and any Exceptional Tree	6		

TOTAL TREE REPLACEMENTS

Less than 10 inches in diameter, not an exceptional tree, and not a replacement tree from another tree permit. *

^{*}no replacement tree is needed if the tree fits all of the following;

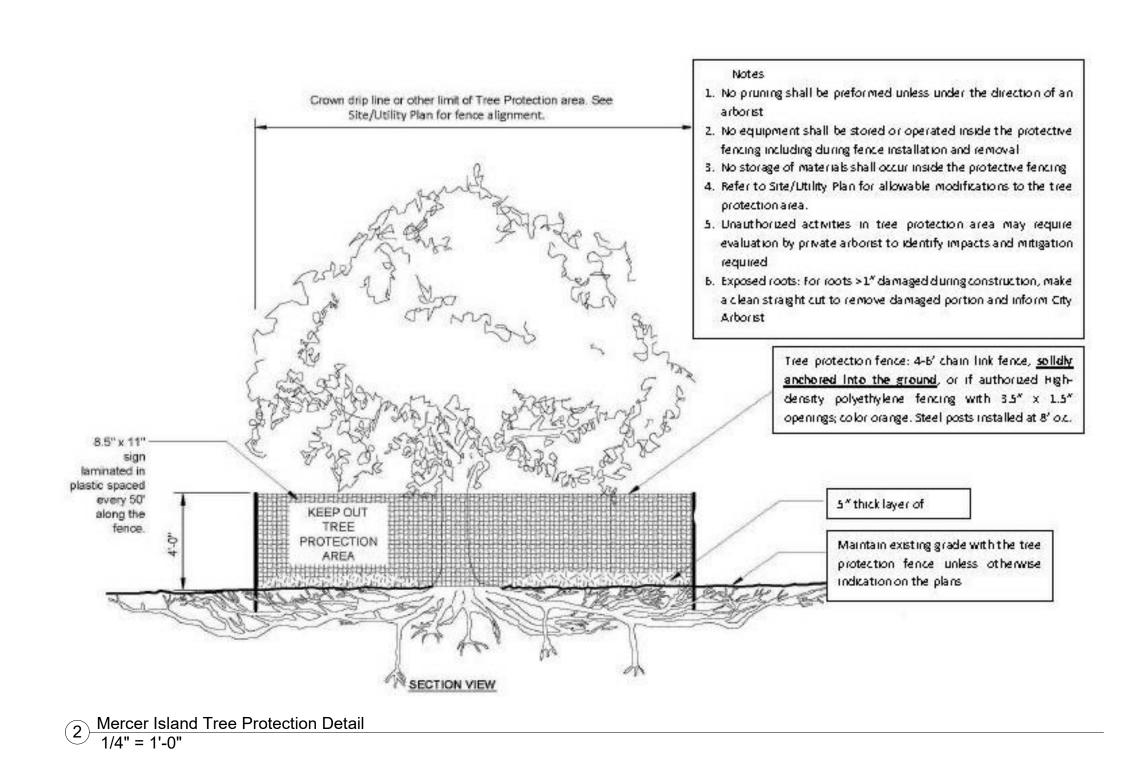


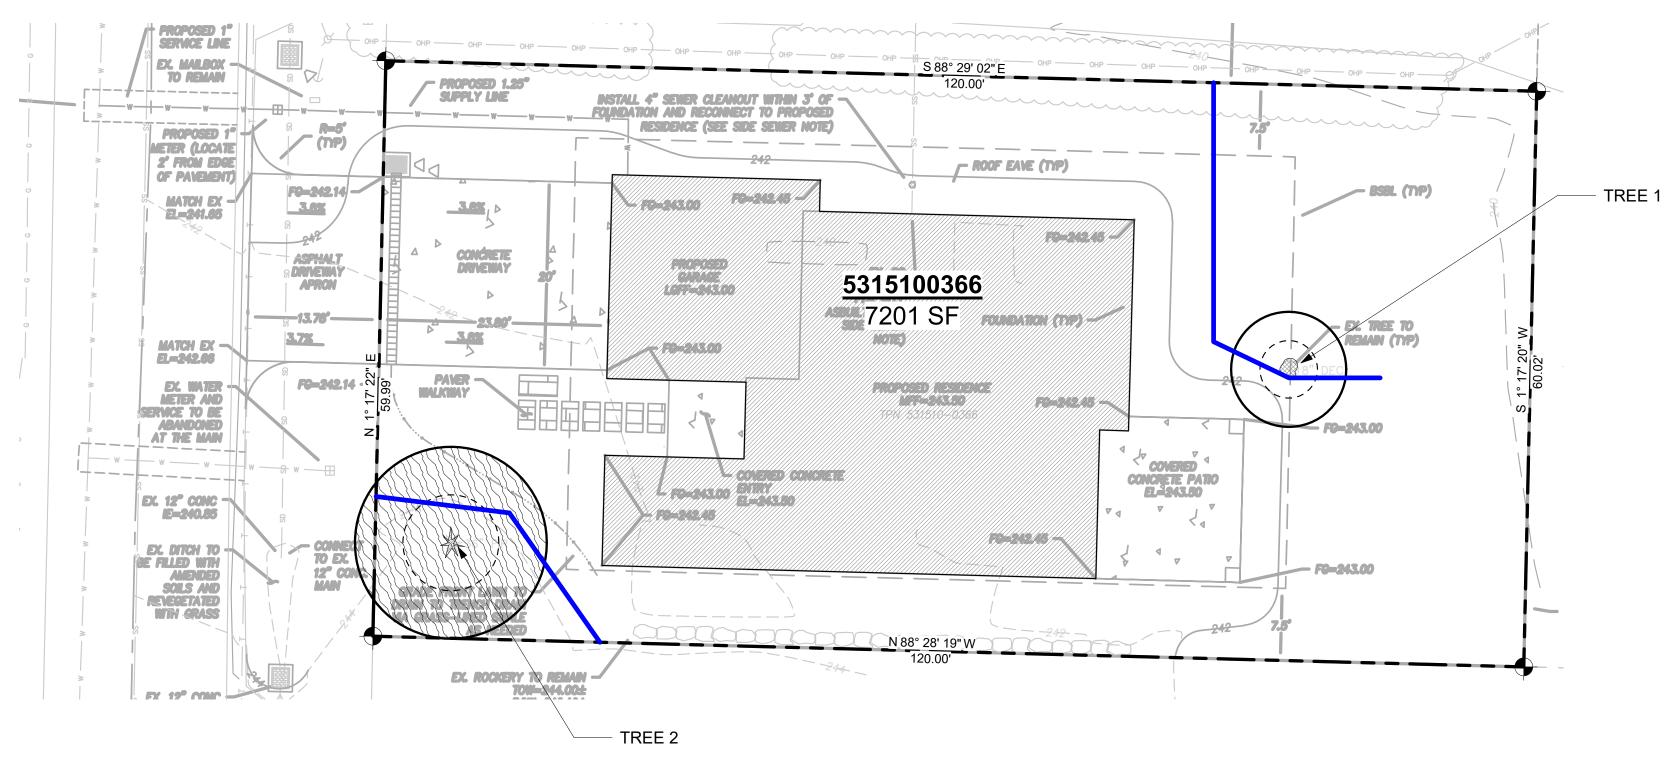

	TREE DRIP LINE (DL)
	DIAMETER STANDARD HEIGHT (DSH)
(*)	EVERGREEN TREE
	DECIDUOUS TREE
X X 1	TREE TO BE REMOVED
	TREE PROTECTION FENCING
•	NEW TREE
	MULCH COVER - 5"-6"

ARBORISTS SITE PLAN

1" = 10'-0"

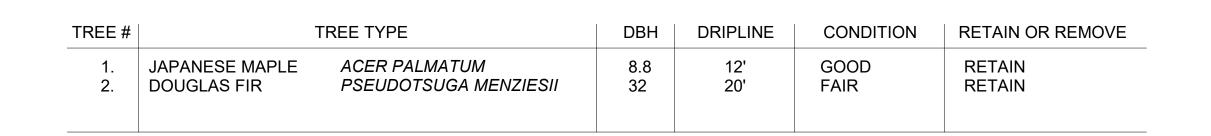

PREPARED BY:

NEAL BAKER
ARBORISTS NW.COM
ISA CERT. PN1075A
TRAQ ISA (TREE RISK ASSESSMENT QUALIFIED)
MEMBER AREA & SOCA
PH: 206 779 2579

arboristsNW

Arborists NW is a full spectrum arboricultural, consulting and landscape design and installation provider. When you think tree and landscape services, think Arborists NW.

ONLINE: https://arboristsnw.com/ PHONE: 206-779-2579 EMAIL: neal@arboristsnw.com

No. Description Date

HU PROJECT

2448 72nd AVE SE Merc

HU PROJECT

ARBORIST TREE PLAN

Project number 22021

Date -
Drawn by CW

Checked by NB

X100

1/12/2023 7:35:41 PM

As indicated